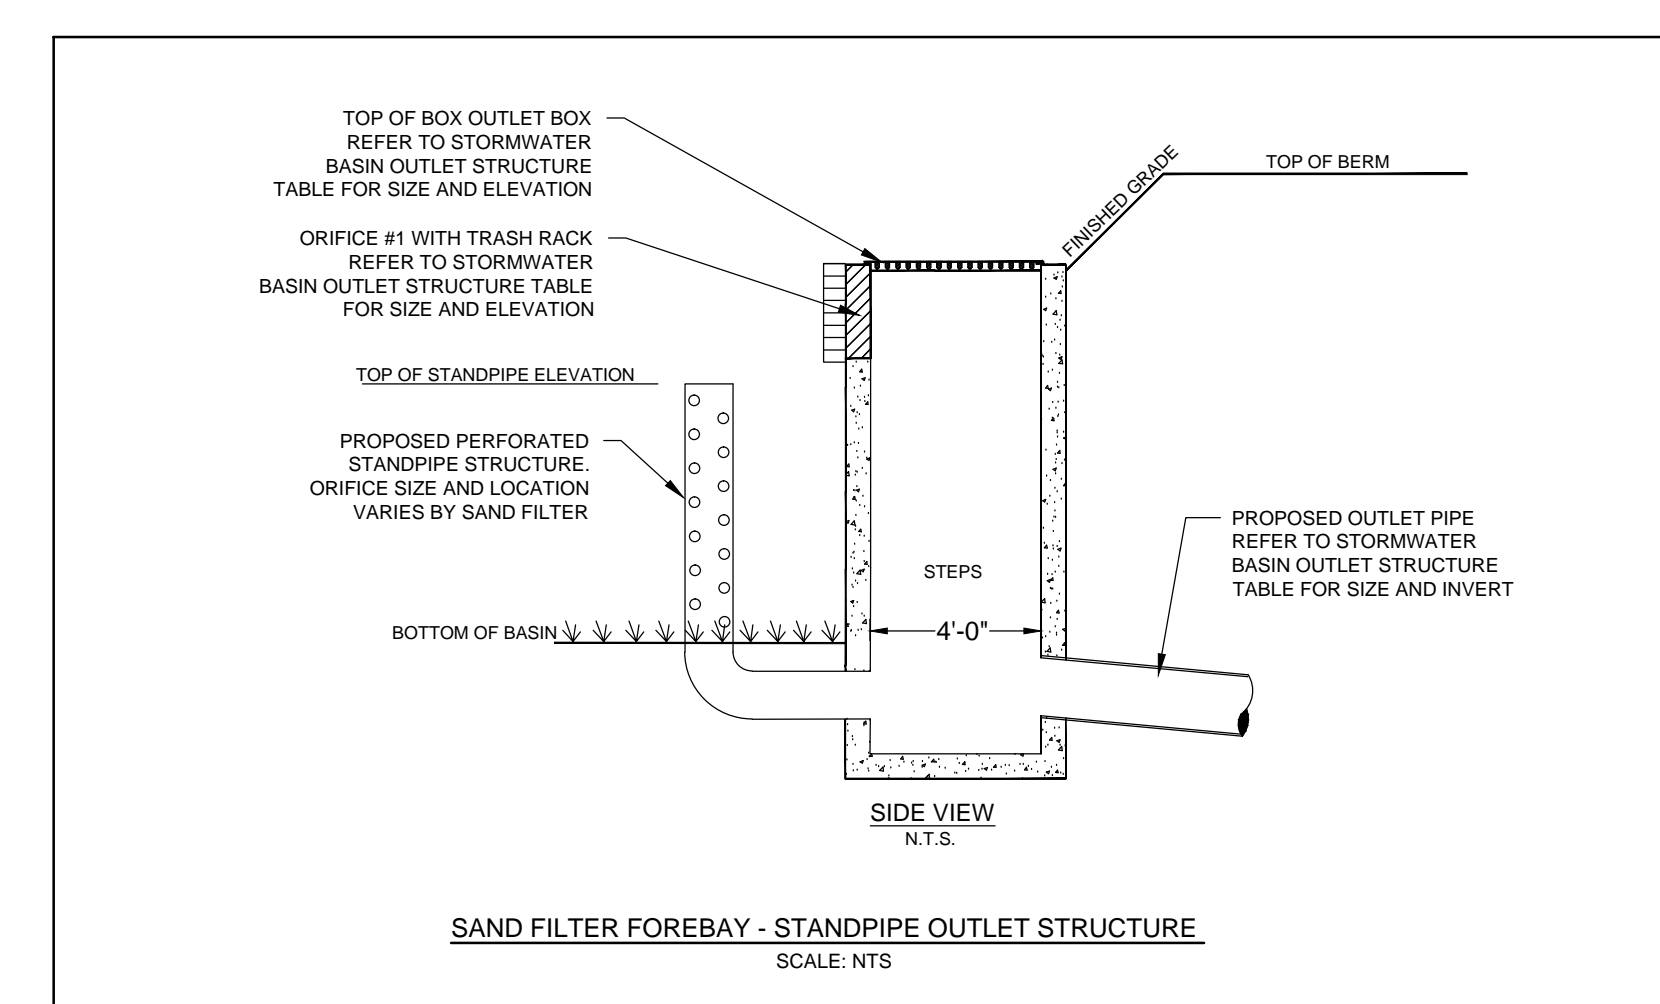
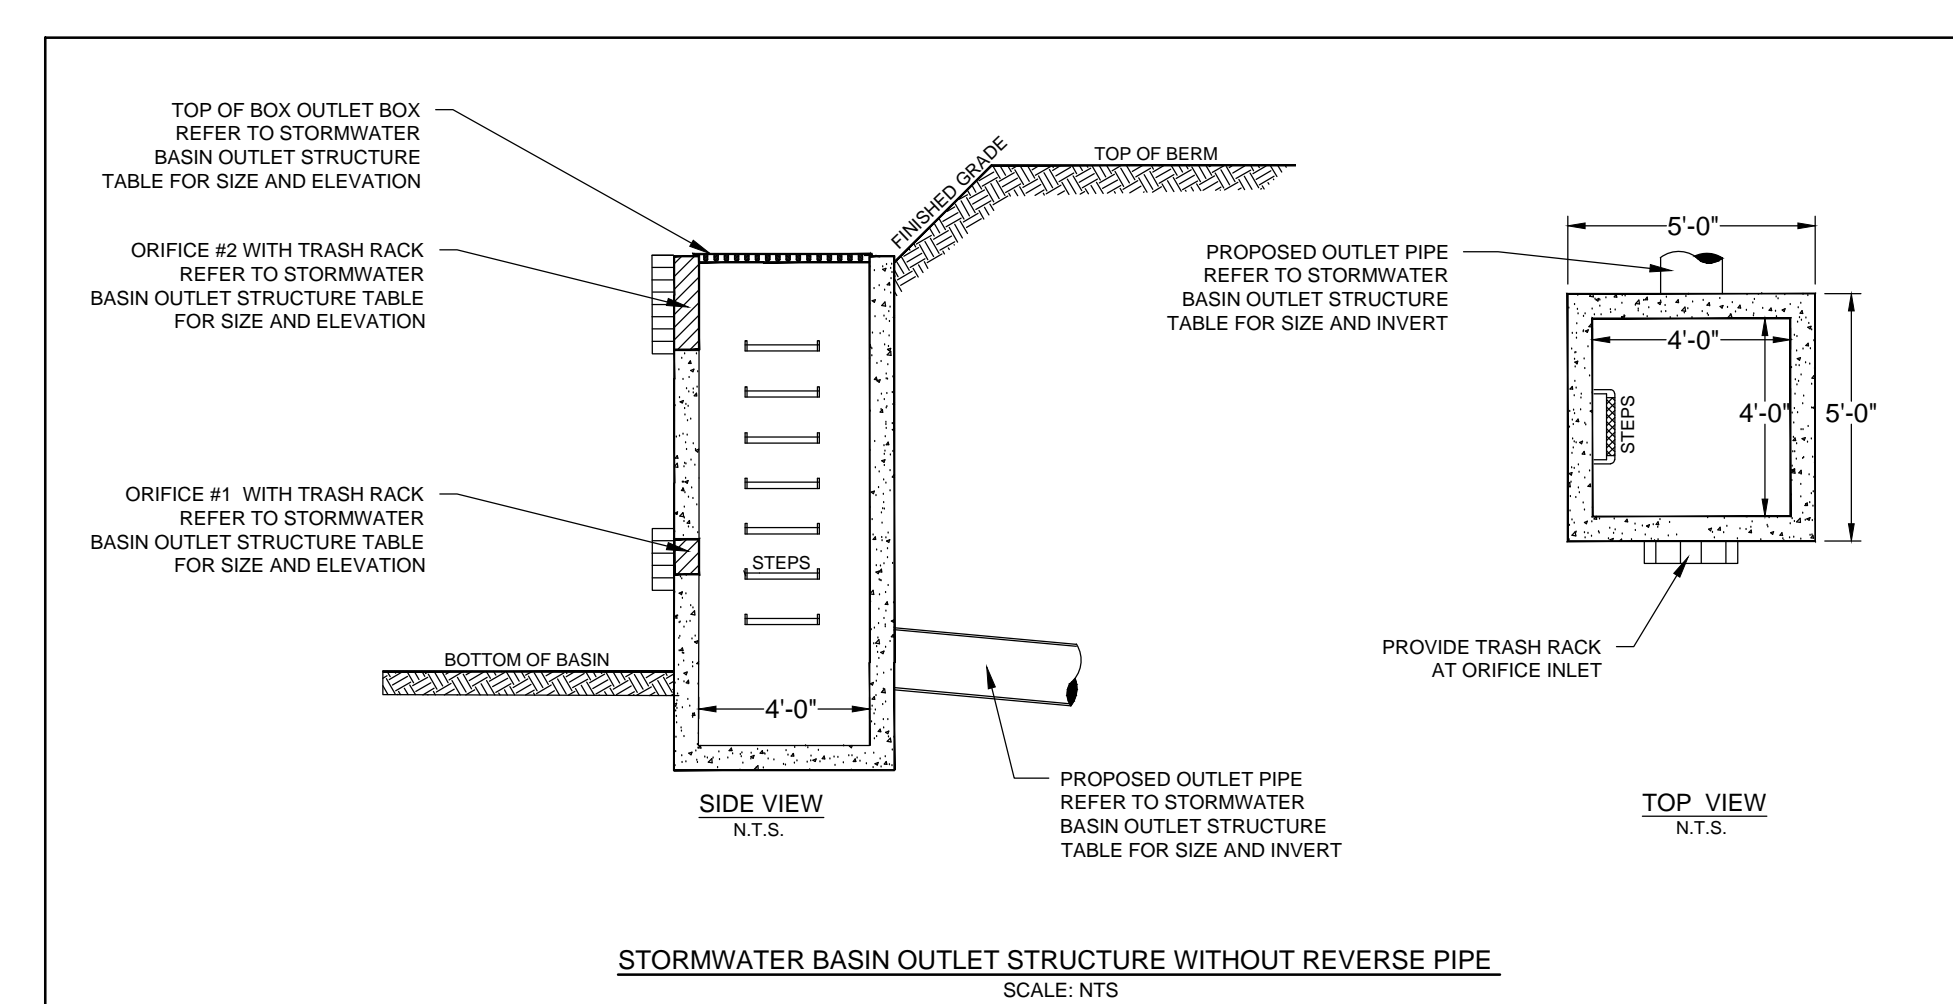
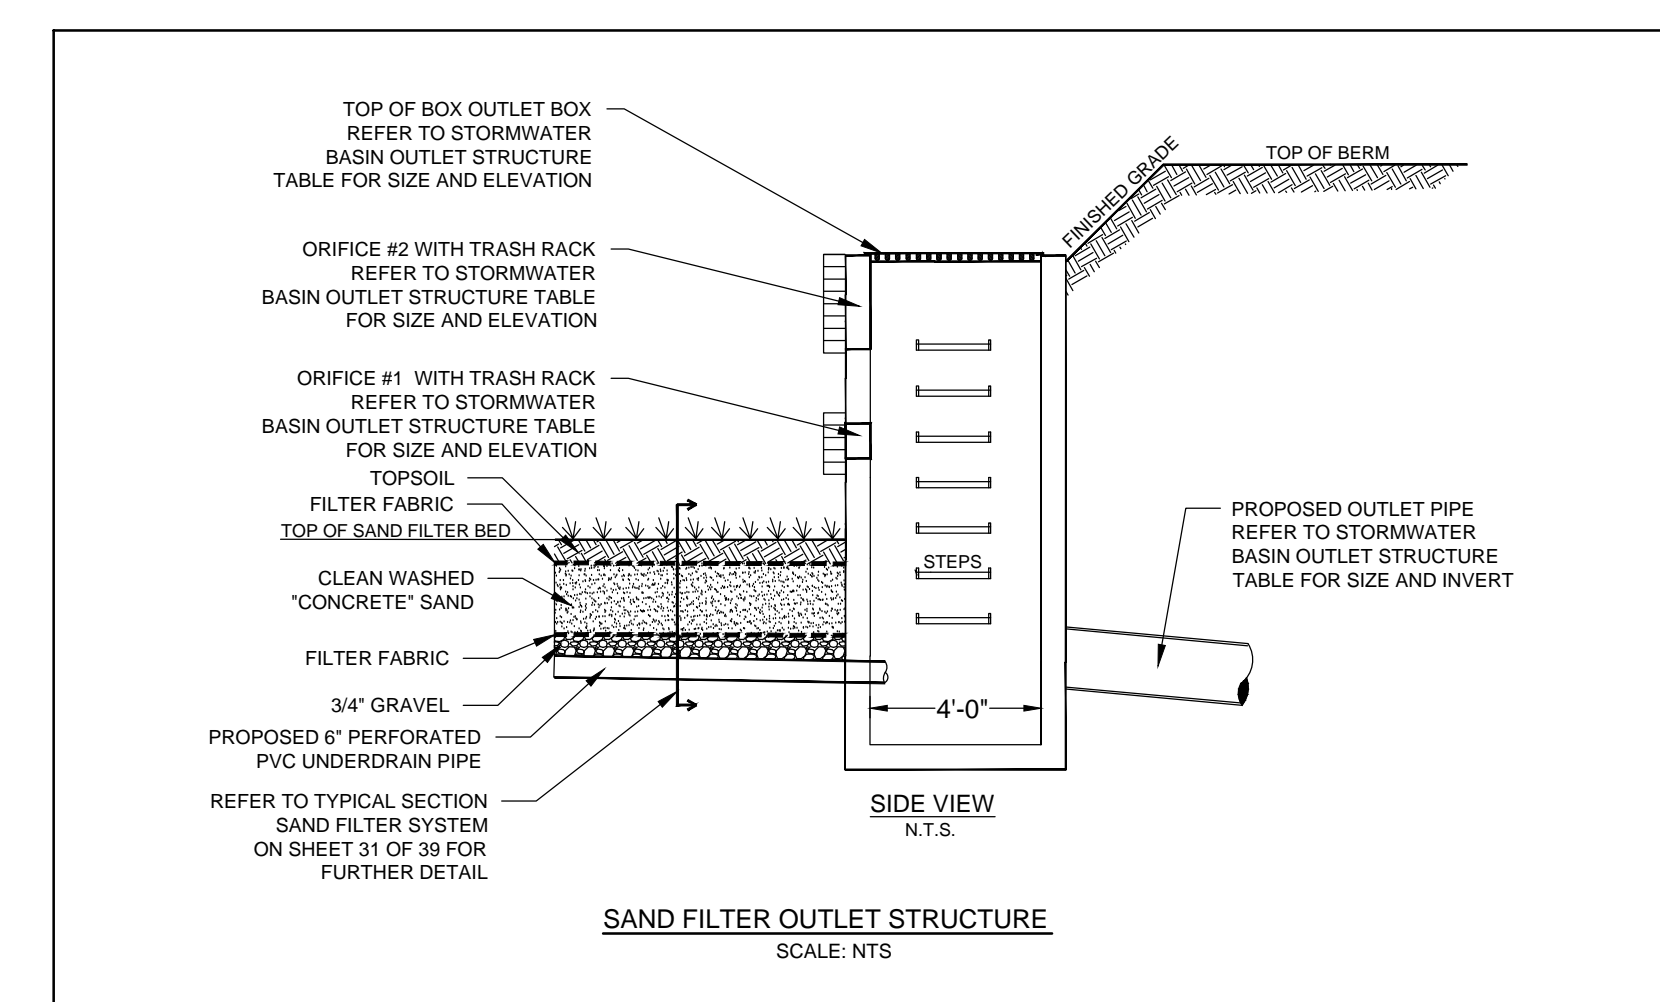
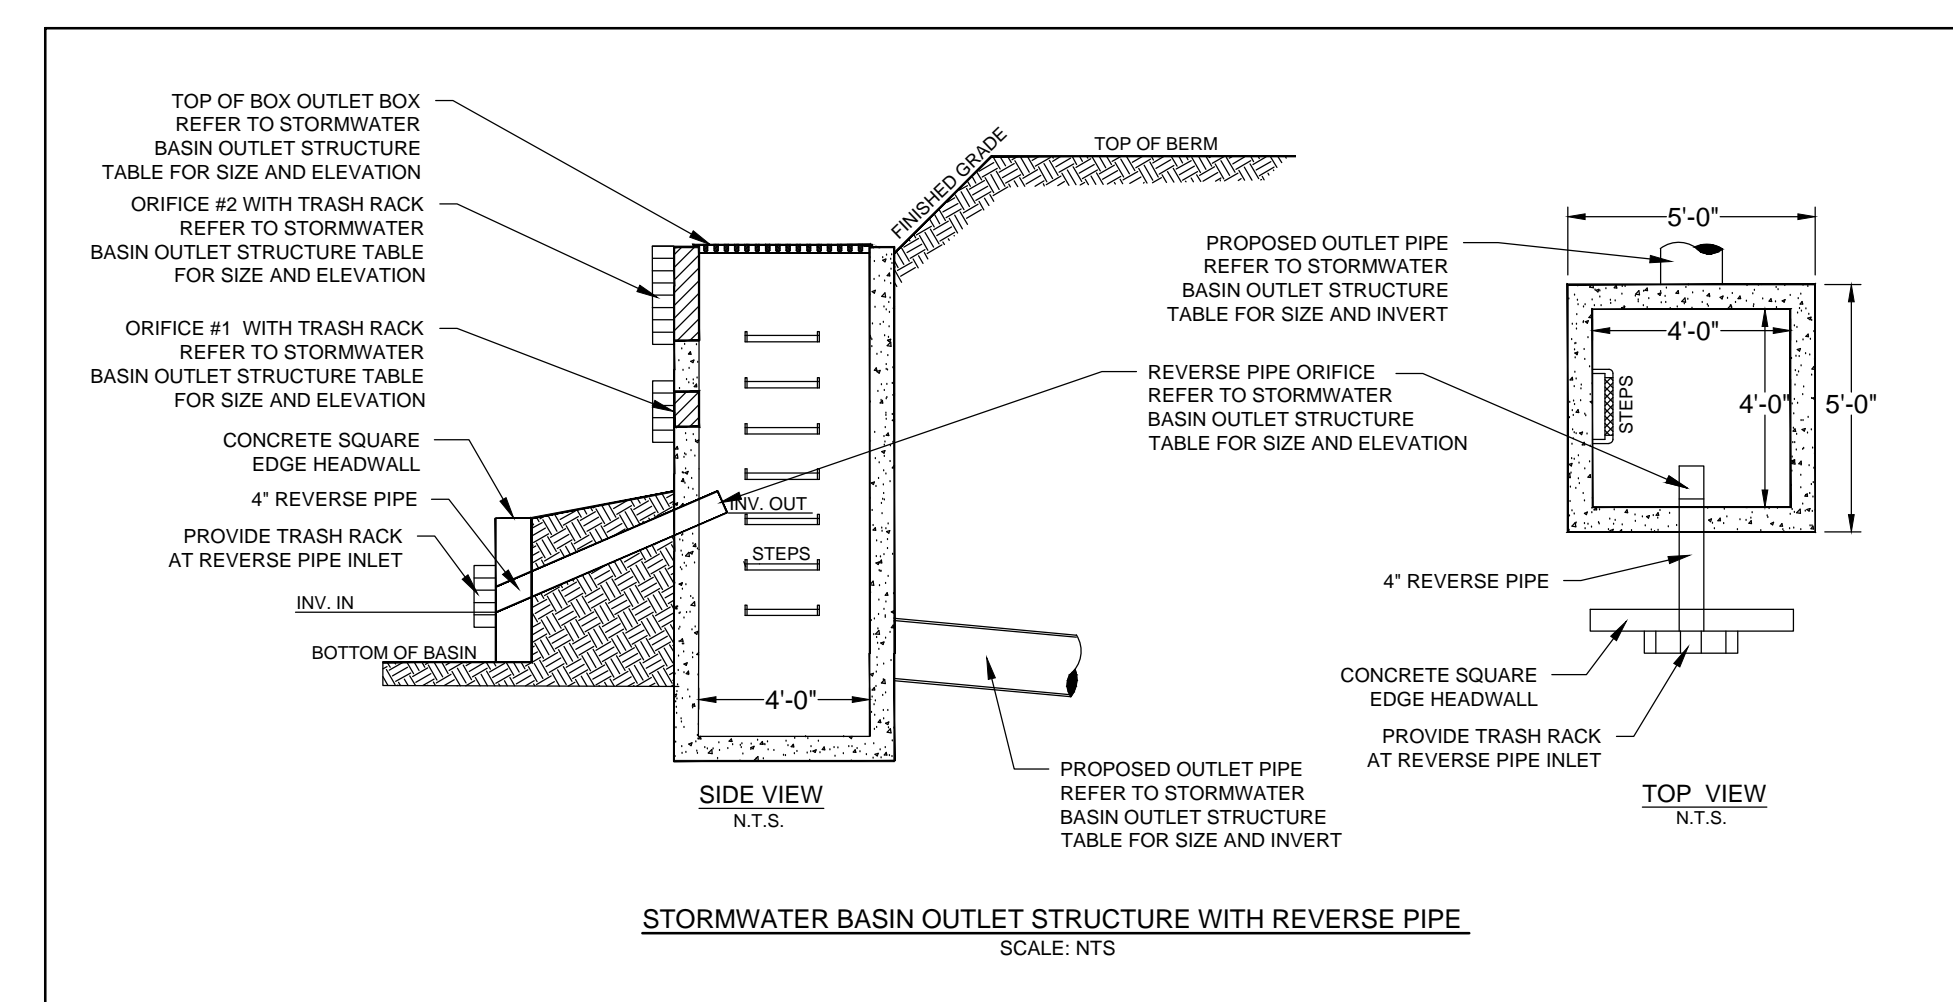
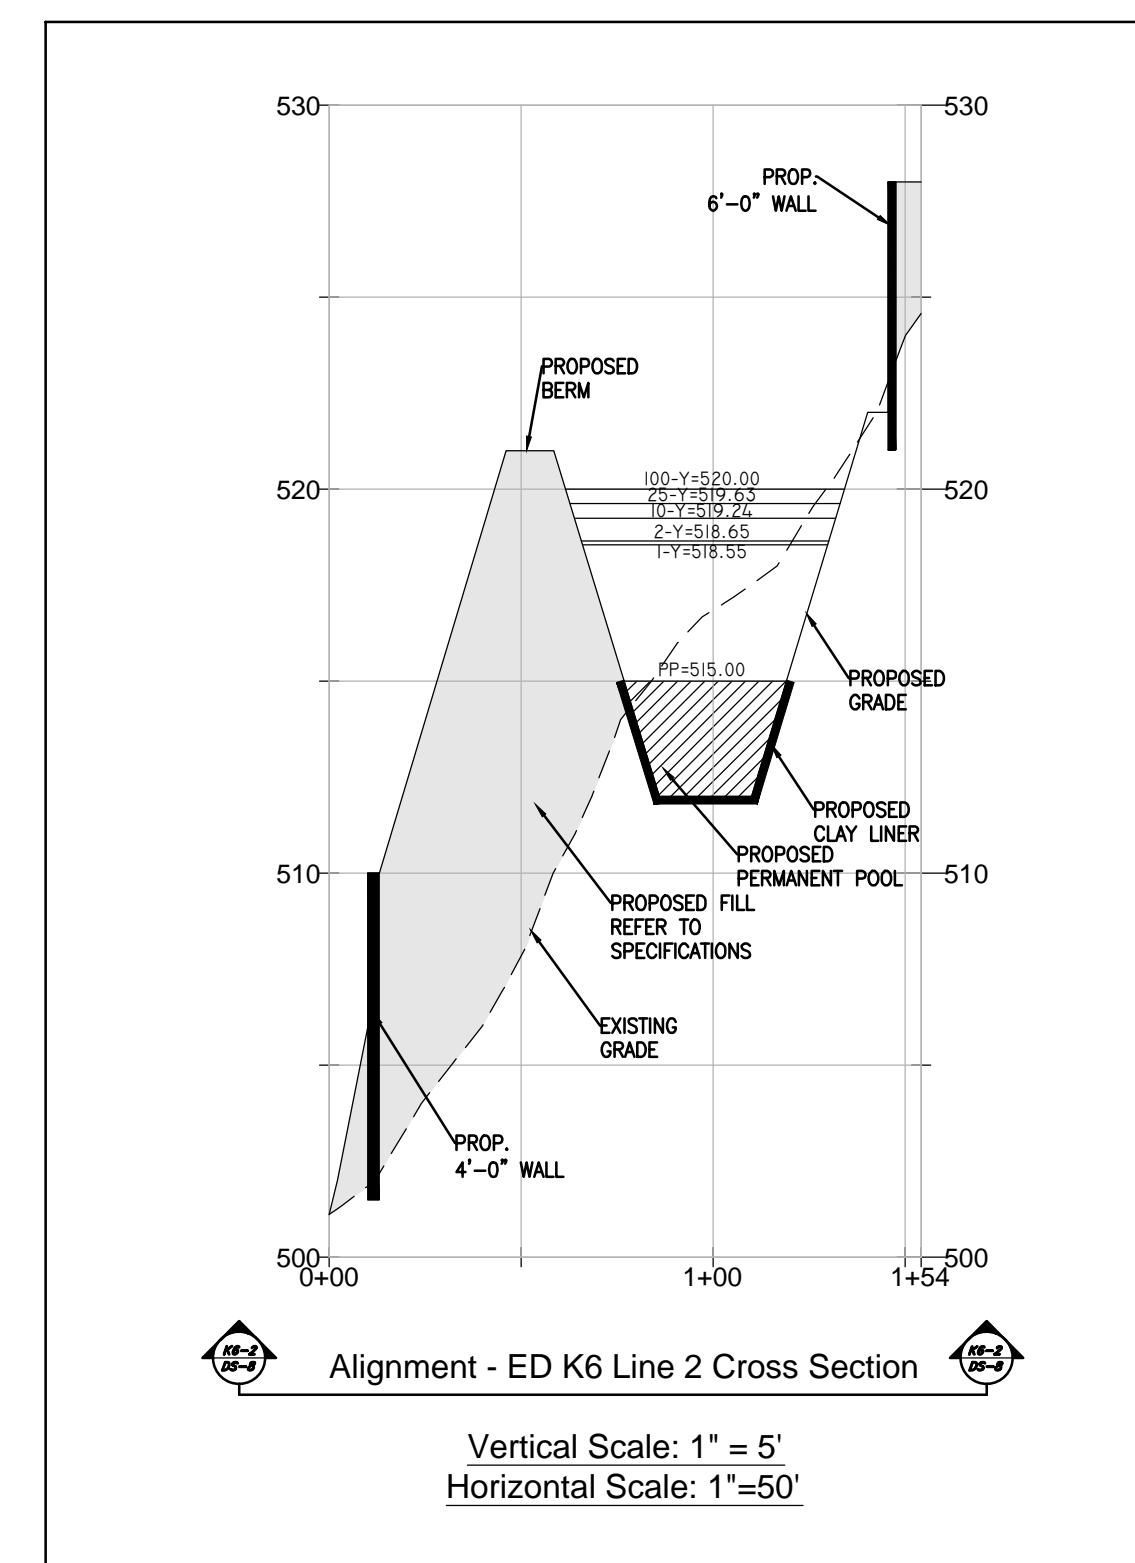
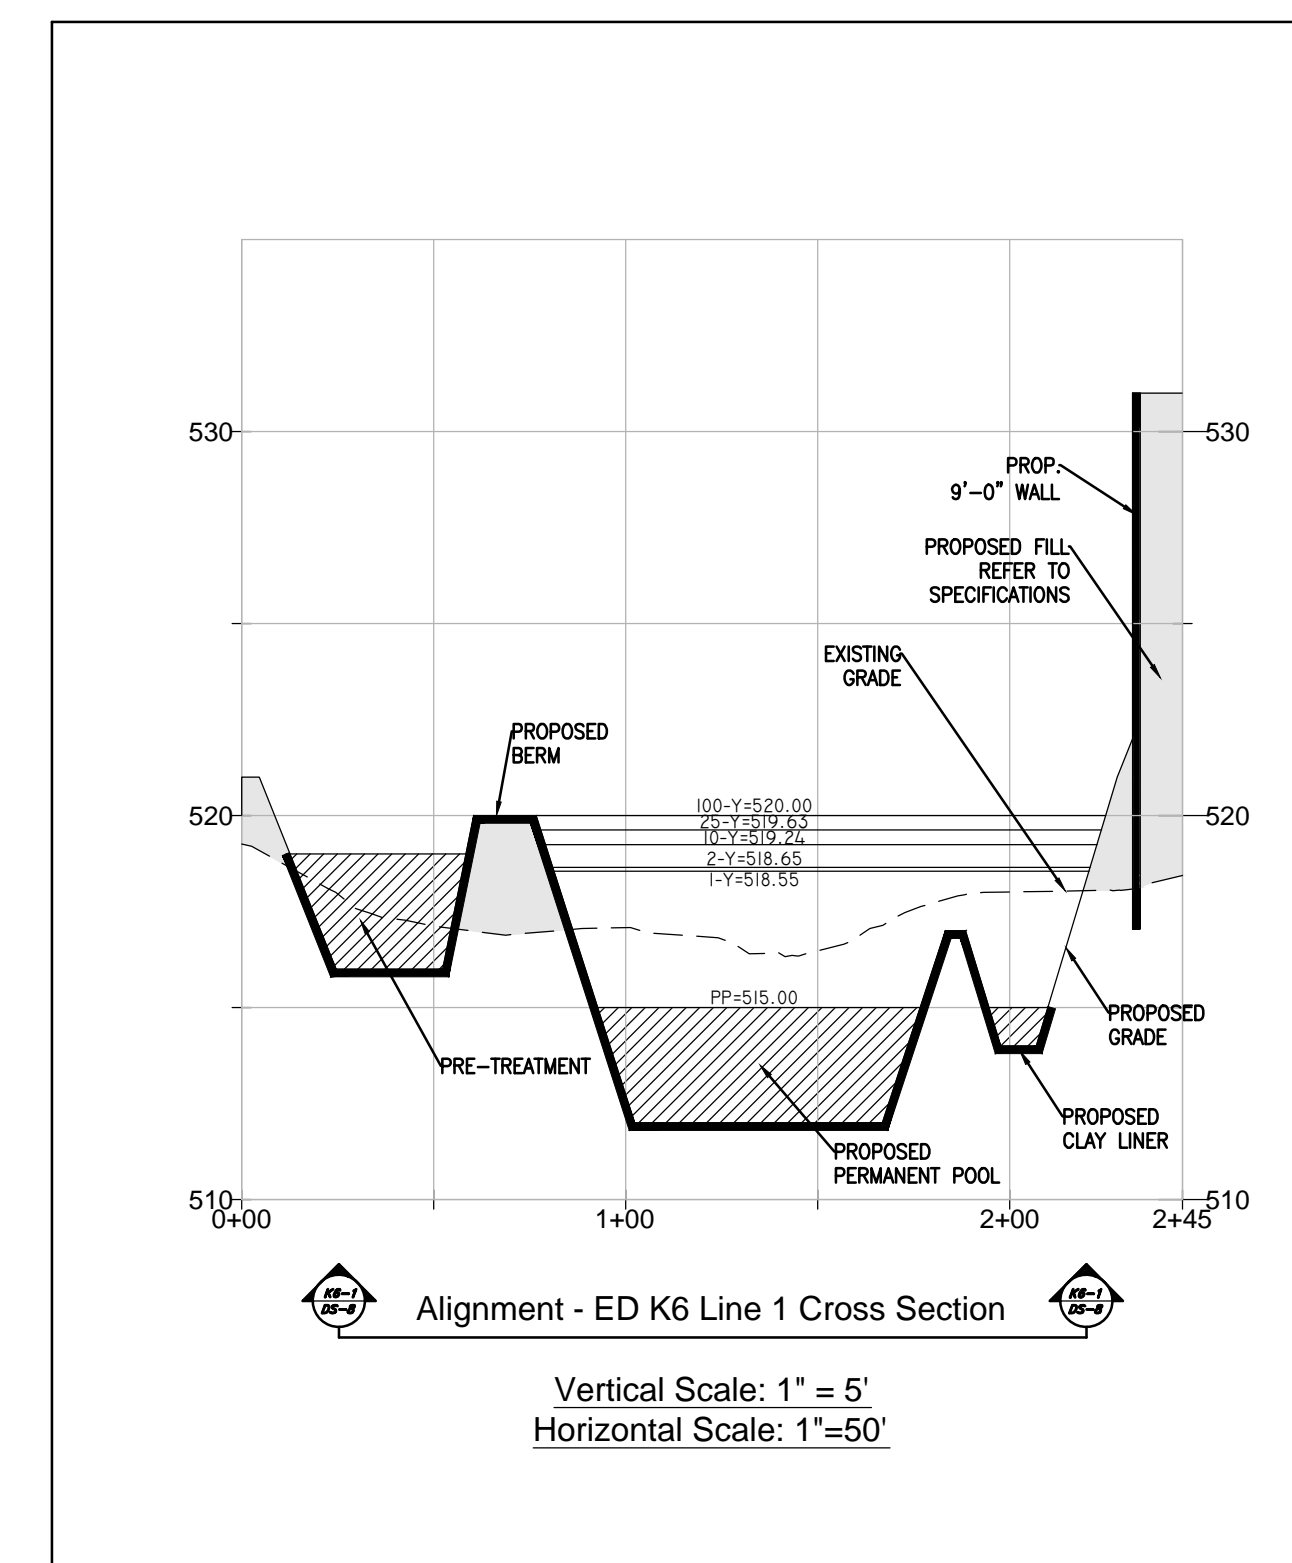
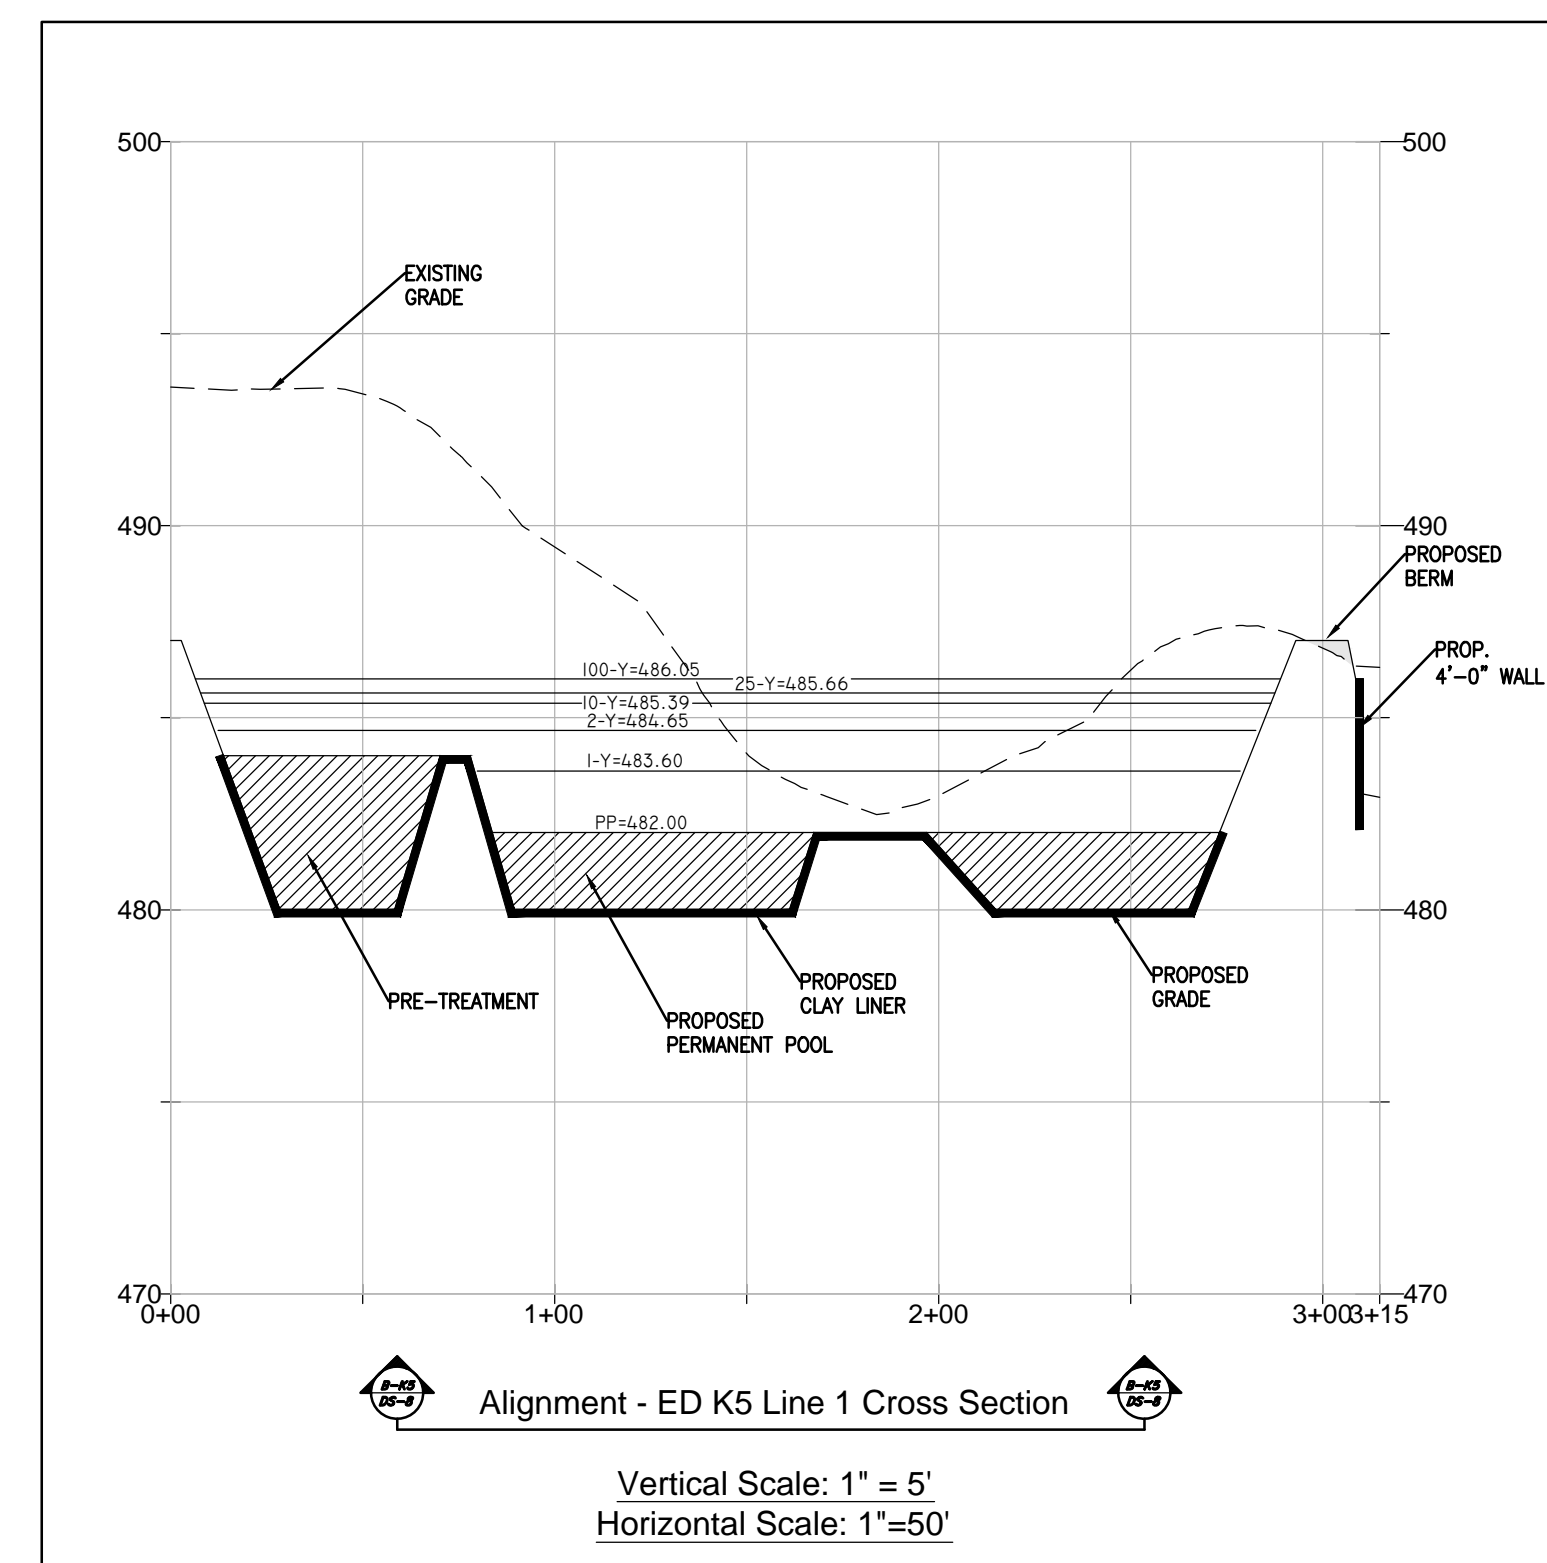
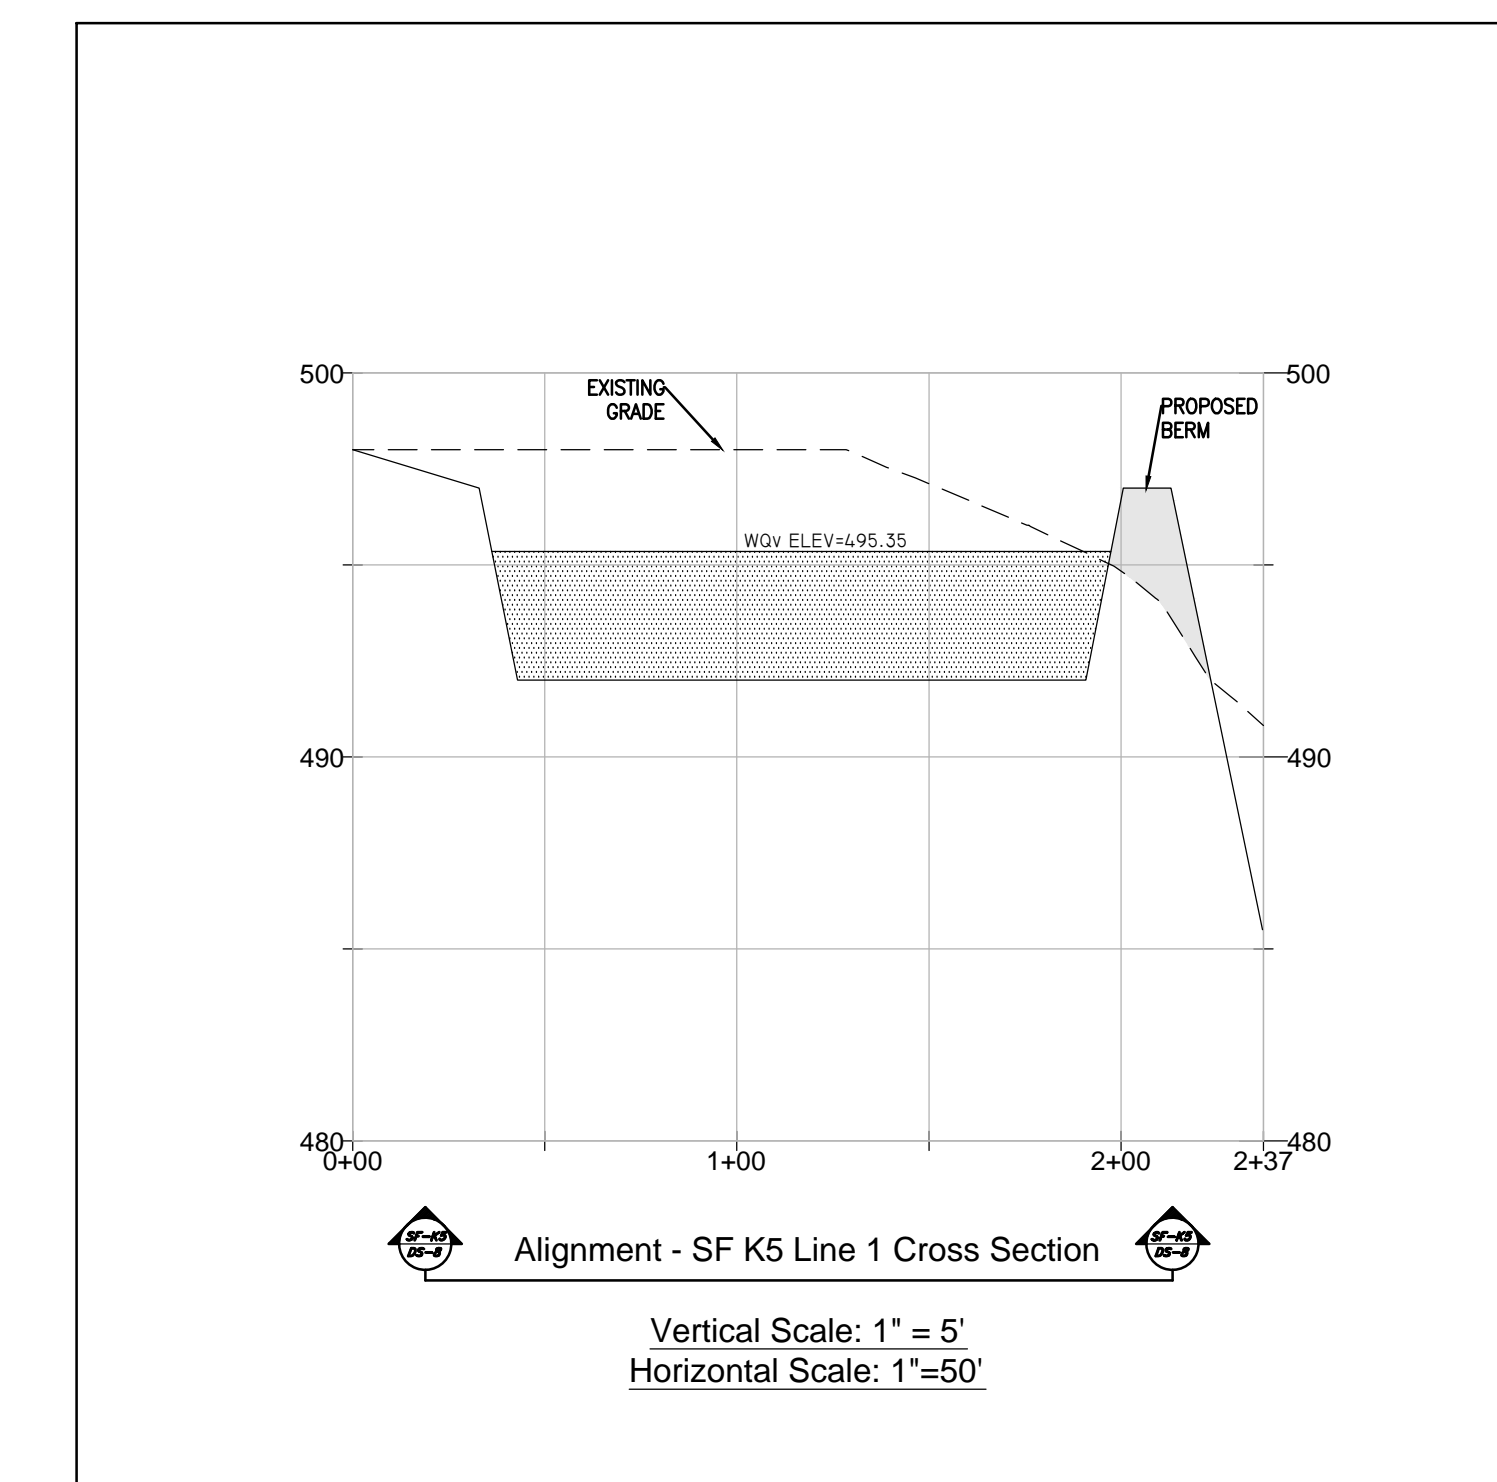
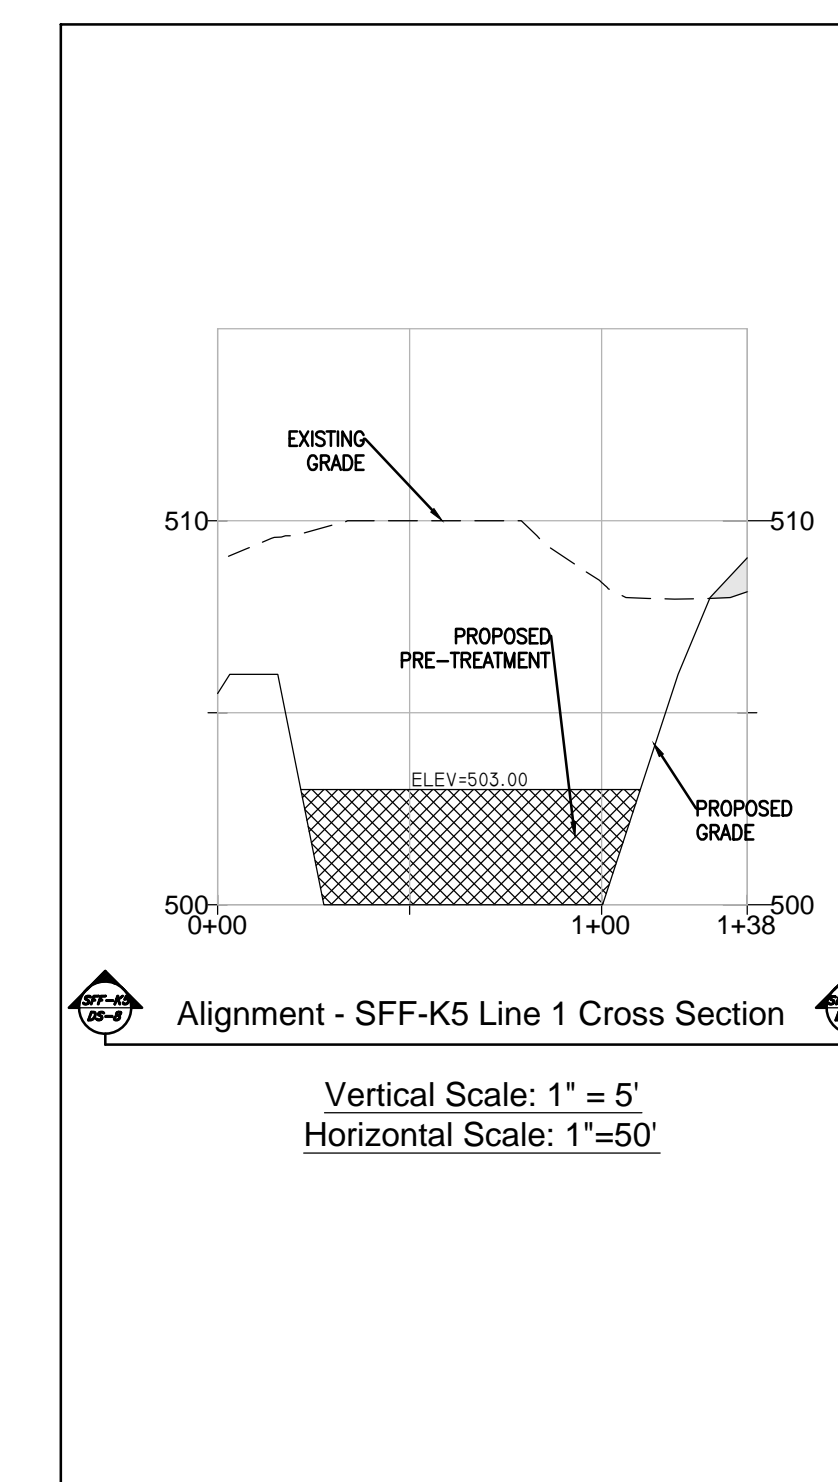
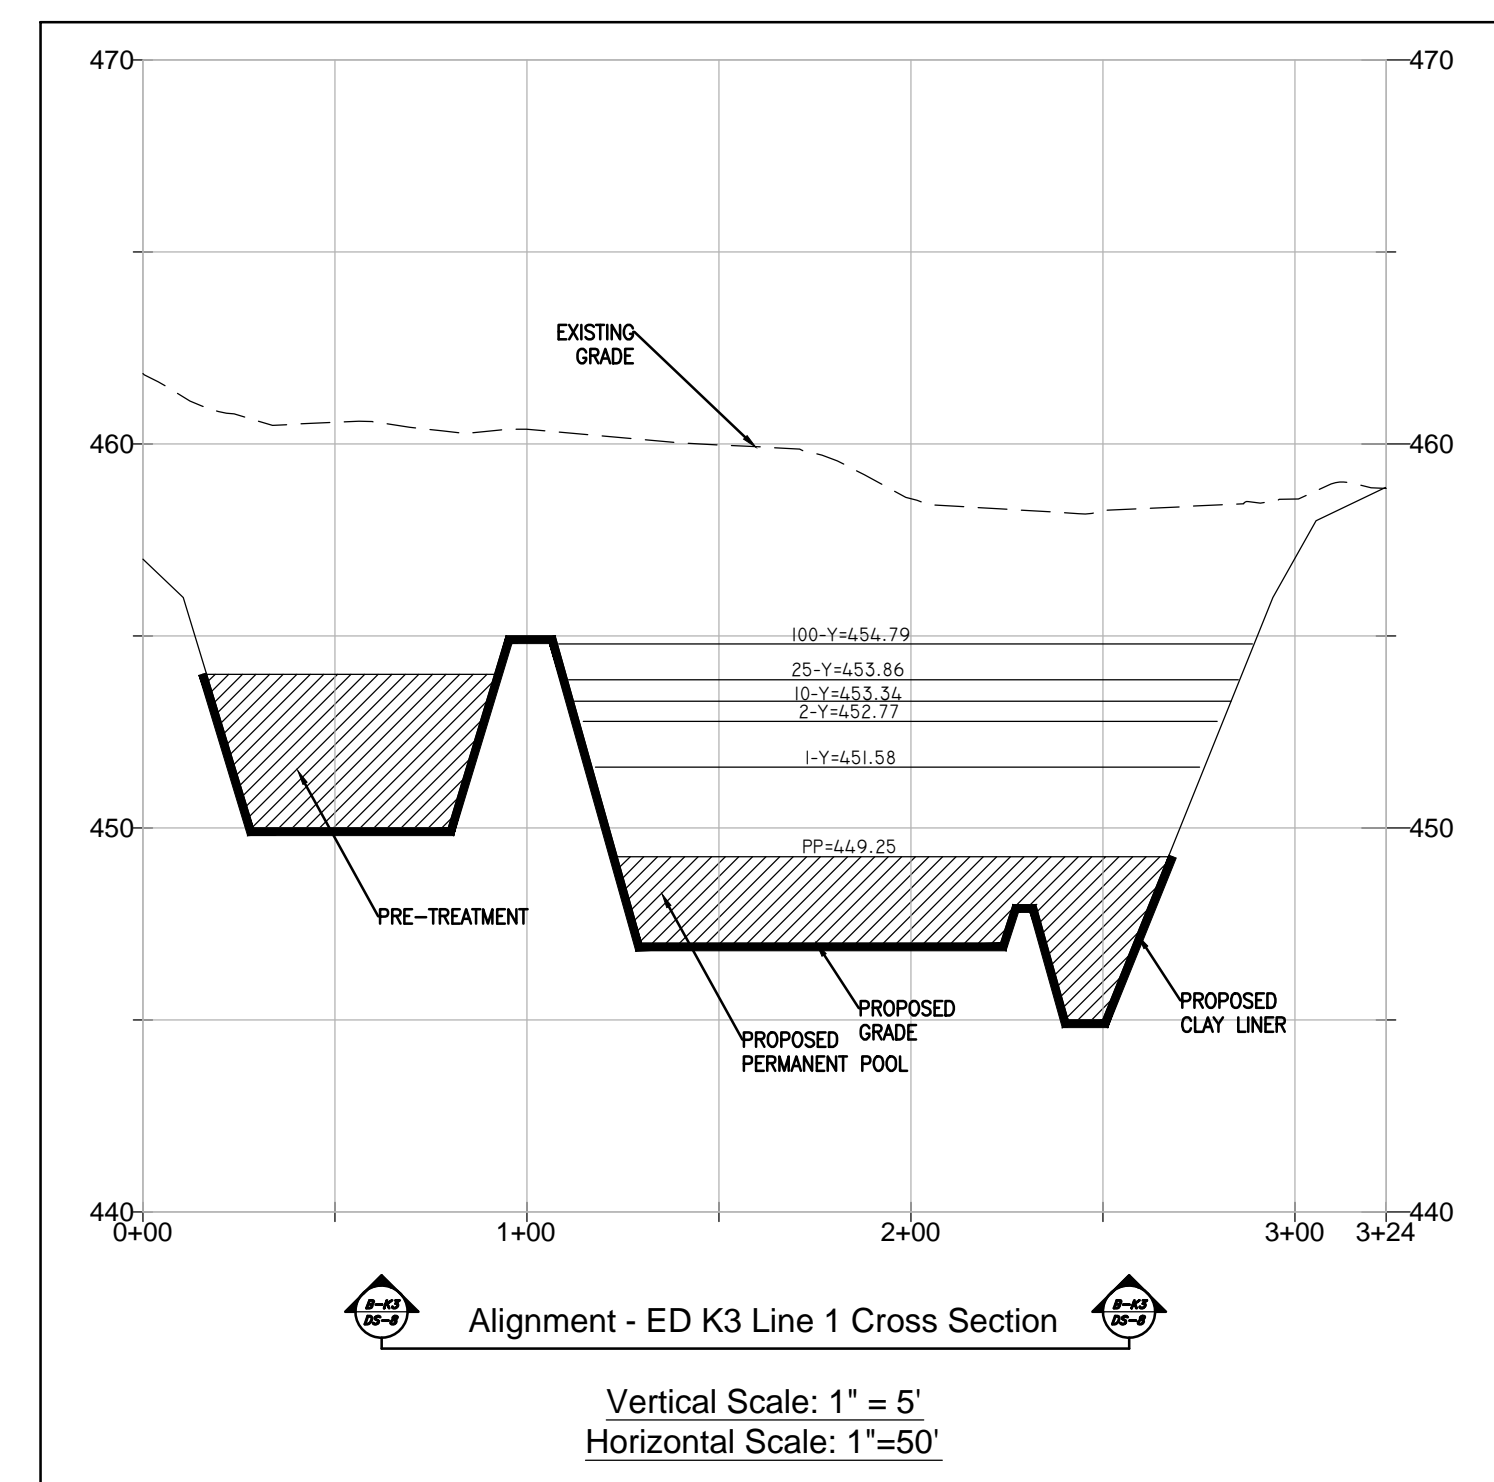
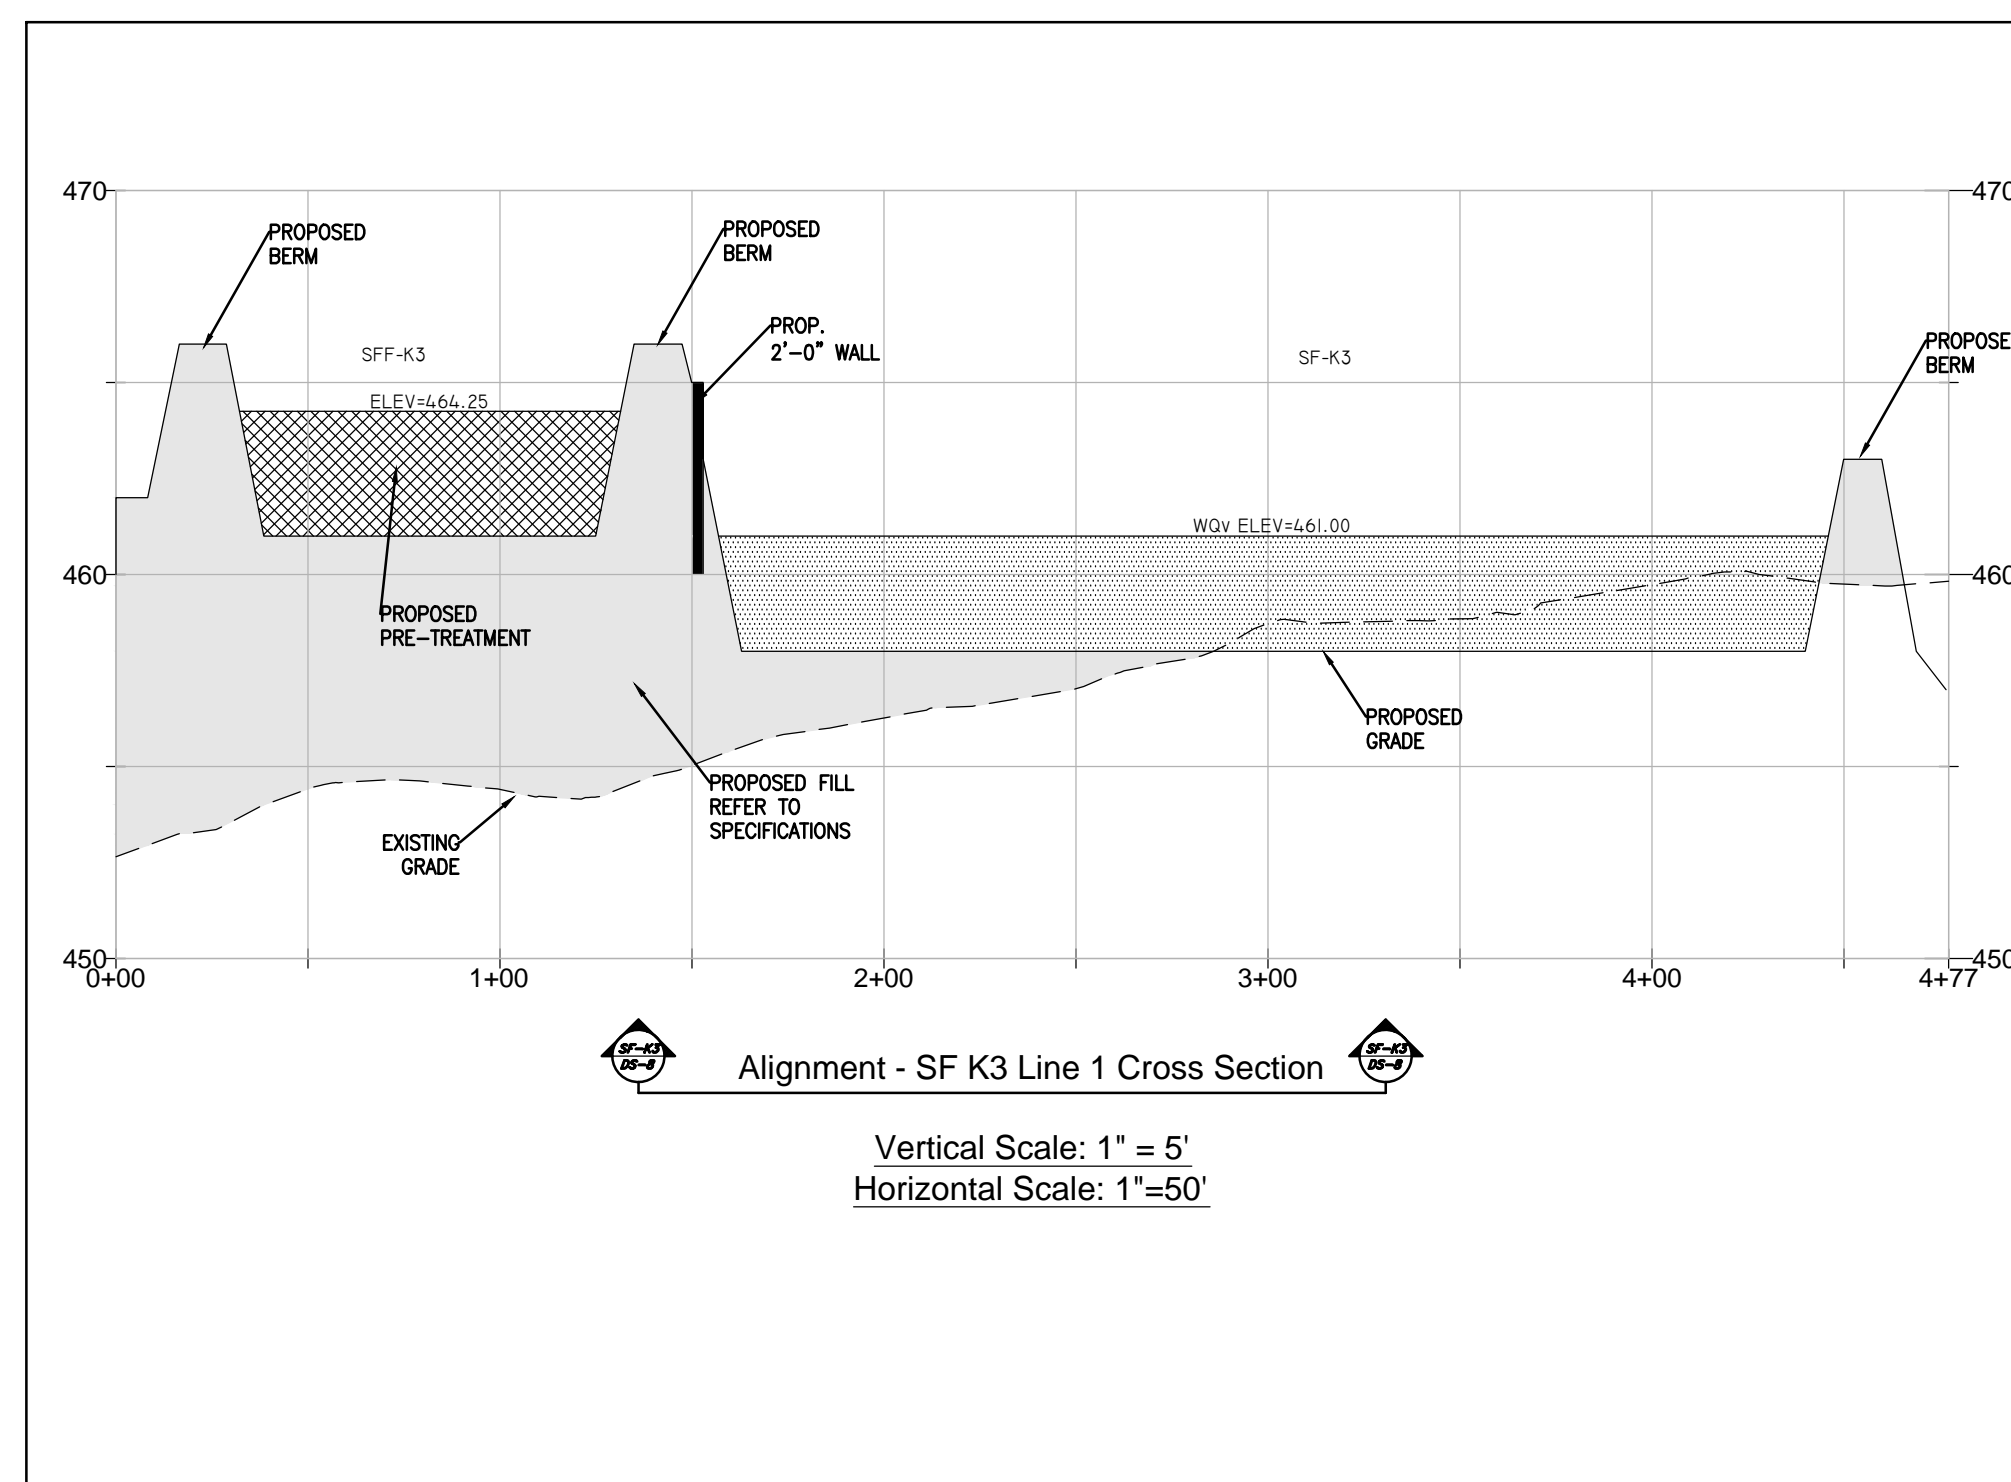
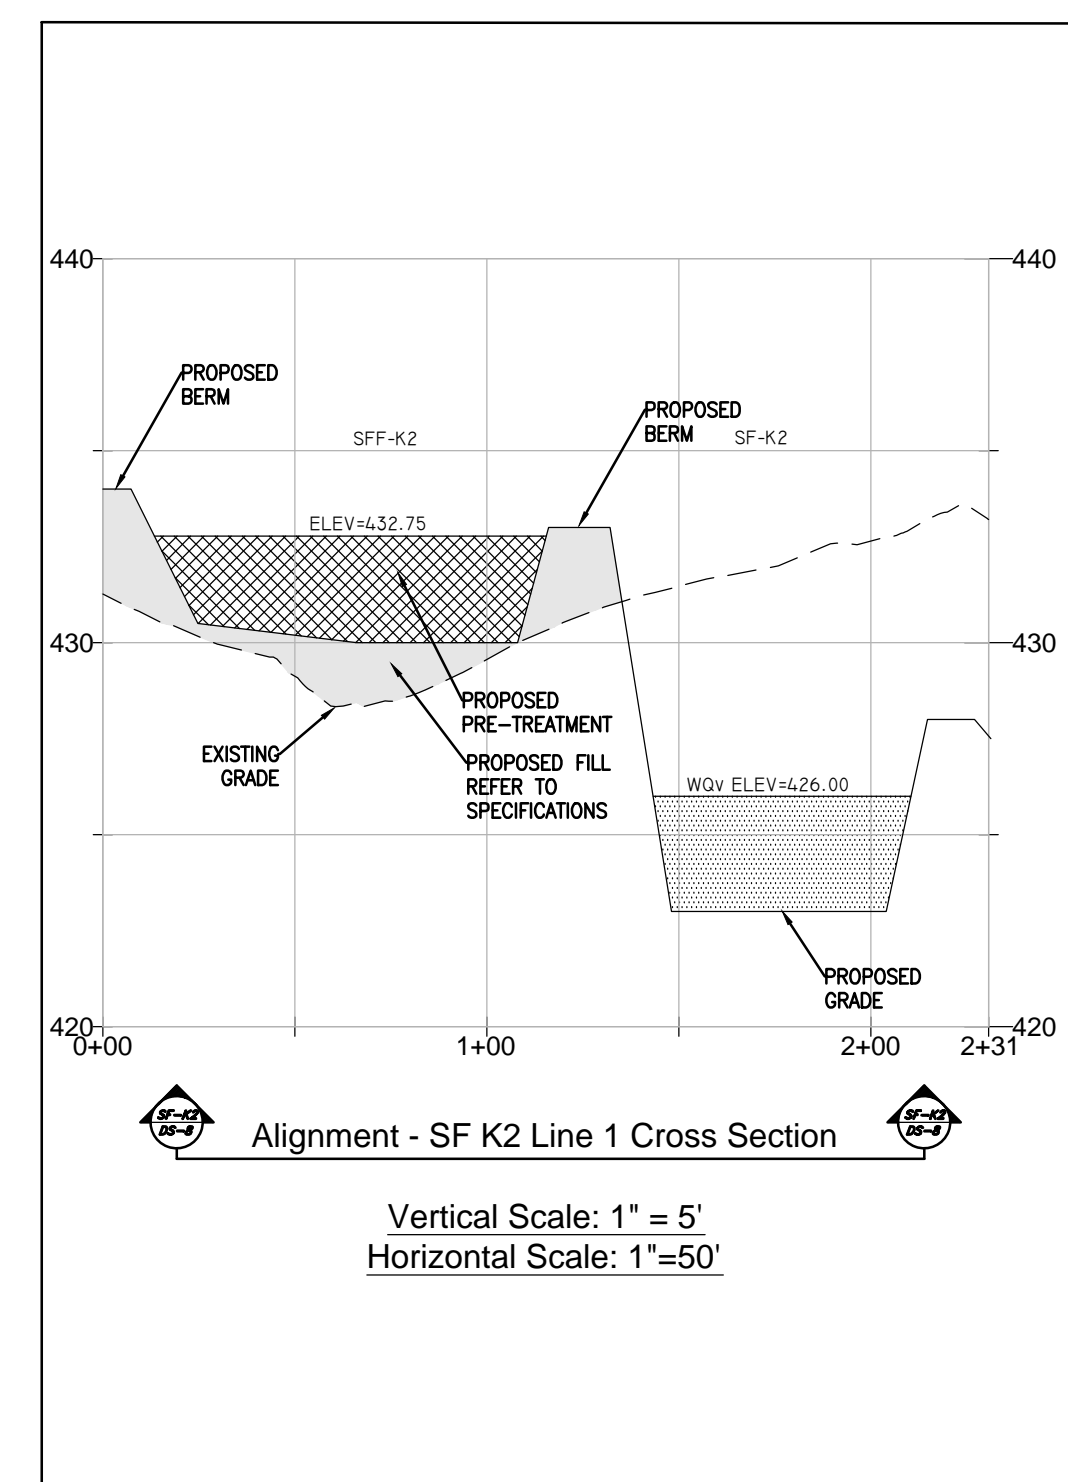


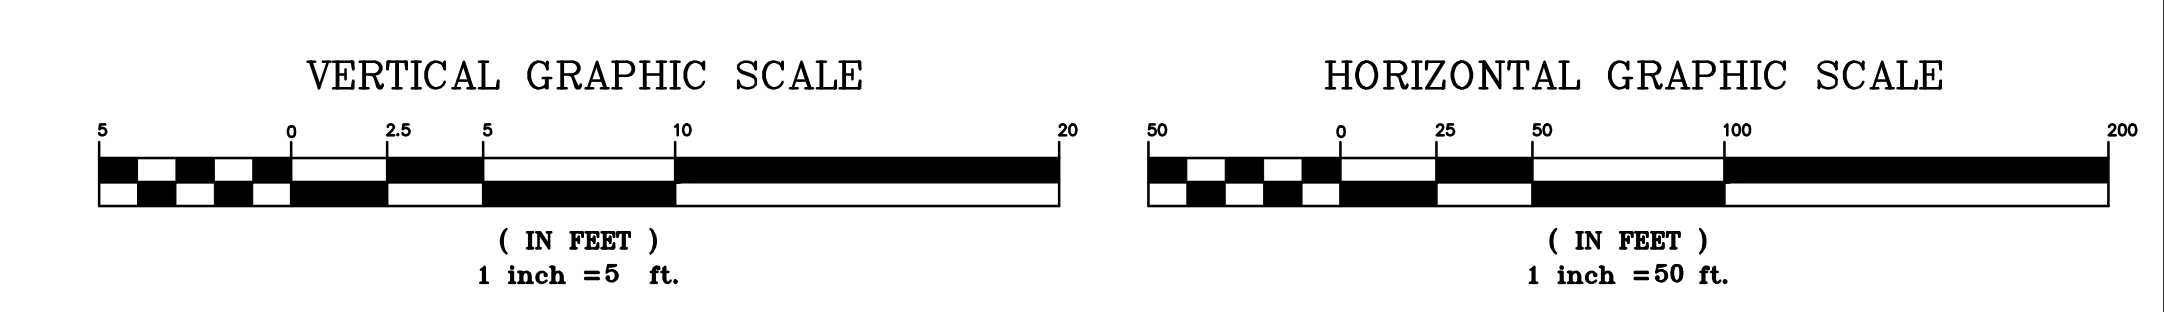
DETENTION BASIN SECTIONS



Basin	Outlet Pipe			RPI/Standpipe/Underdrain			Orifice #1			Orifice #2			Orifice #3			Top of Outlet Box		Emergency Overflow	
	Size (in)	Inv. In	Inv. Out	Size (in)	Type	Inv.	Size (in)	Type	Inv.	Size (in)	Type	Inv.	Size (in)	Type	Inv.	Size (in)	Inv.	Size (ft)	Inv.
SFF-A3a	15	337.00	336.90	12	S.P.	338.75	-	-	-	-	-	-	-	-	-	24 x 24	338.75	8	339.00
SF-A3a	12	332.50	332.10	6	U.D.	332.50	-	-	-	-	-	-	-	-	-	48 x 48	336.85	10	337.10
SFF-A3b	15	348.00	347.50	12	S.P.	350.00	18 x 12	R.V.O. (2)	350.00	-	-	-	-	-	-	24 x 24	351.00	8	351.00
SF-A3b	12	339.5	338.7	6	U.D.	339.50	12 x 12	R.V.O.	344	-	-	-	-	-	-	36 x 36	344.9	10	345
ED-A4	24	358.00	356.00	2	RPI	361.25/363	13 x 9	R.V.O.	364.47	22 x 12	R.V.O. (2)	366.00	-	-	-	48 x 48	366.97	10	367.00
SFF-B2	12	456.00	440.00	12	S.P.	458.55	-	-	-	-	-	-	-	-	-	-	-	8	459.00
SF-B2	12	431.5	428	6	U.D.	431.50	12 x 12	R.V.O.	437	-	-	-	-	-	-	36 x 36	438	10	438
B-B3	36	414.00	404.00	-	-	-	6	C.V.O.	420.50	18 x 12	R.V.O. (3)	424.00	-	-	-	48 x 48	425.00	10	425.00
PW-C2	18	460	449	1.7	RPI	460.75/463	13 x 11	R.V.O. (4)	465.05	-	-	-	-	-	-	48 x 48	465.98	10	466
SFF-G1	12	520.00	519.50	15	S.P.	522.90	-	-	-	-	-	-	-	-	-	48 x 48	522.90	8	523.00
SF-G1	12	515.50	515.12	6	U.D.	515.50	12 x 12	R.V.O.	519.50	-	-	-	-	-	-	48 x 48	520.00	10	521.00
B-G1	18	511.00	509.00	-	-	-	4	C.V.O.	512.50	28 x 18	R.V.O.	514.00	-	-	-	36 x 36	516.00	10	517.00
I-G2	15	447.00	437.00	-	-	-	24 x 12	R.V.O.	451.50	-	-	-	-	-	-	36 x 36	453.00	10	453.00
I-G3a	18	399.00	389.00	-	-	-	24 x 7	R.V.O. (3)	402.42	-	-	-	-	-	-	48 x 48	402.85	10	403.00
I-G3b	15	439.00	429.00	-	-	-	18 x 11	R.V.O. (2)	442.08	-	-	-	-	-	-	48 x 48	442.96	10	443.00
B-G4a	48x24	418.00	416.00	-	-	-	1	C.V.O.	420.00	5	C.V.O.	422.75	20 x 10	R.V.O. (2)	424.00	48 x 48	424.85	10	425.00
SFF-G5	12	432.00	431.50	15	S.P.	434.90	-	-	-	-	-	-	-	-	-	24 x 24	434.90	10	435.00
SF-G5	12	425.50	425.15	6	U.D.	425.50	-	-	-	-	-	-	-	-	-	36 x 36	430.9	10	431.00
B-G5	24	419.00	416.00	-	-	-	4	C.V.O.	420.50	21.4 x 12	R.V.O. (2)	424.00	-	-	-	36 x 36	425.00	10	425.00
SFF-G6	12	460.00	459.00	24	S.P.	462.80	-	-	-	-	-	-	-	-	-	36 x 36	462.80	10	463.00
SF-G6	12	453.50	453.00	6	U.D.	453.50	-	-	-	-	-	-	-	-	-	48 x 48	458.75	10	459.00
B-G6	24	447.50	446.50	-	-	-	4	C.V.O.	448.50	24 x 12	R.V.O. (2)	451.90	-	-	-	36 x 36	452.90	10	453.00
SFF-G7	8	452.00	451.50	15	S.P.	454.80	-	-	-	-	-	-	-	-	-	24 x 24	454.90	10	455.00
SF-G7	12	445.50	442.00	6	U.D.	445.50	-	-	-	-	-	-	-	-	-	36 x 36	450.85	10	451.00
SFF-K2	12	430.00	428.00	24	S.P.	432.75	-	-	-	-	-	-	-	-	-	36 x 36	432.85	10	433.00
SF-K2	15	420.50	420.00	6	U.D.	420.50	24 x 9	R.V.O. (2)	426.00	-	-	-	-	-	-	48 x 48	426.75	10	427.00
SFF-K3	36	462.00	461.00	24	S.P.	464.25	24 x 8	R.V.O. (3)	464.25	-	-	-	-	-	-	36 x 36	464.92	10	465.00
SF-K3	36	453.00	455.00	6	U.D.	455.50	26 x 8	R.V.O. (6)	461.00	-	-	-	-	-	-	48 x 48	464.65	10	465.00
ED-K3	24	446.50	445.50	2	RPI	448.449.25	24 x 11	R.V.O. (2)	453.00	-	-	-	-	-	-	48 x 48	454.75	10	455.00
SFF-K5	24	500.00	495.00	18	S.P.	503.00	24 x 11	R.V.O. (3)	504.00	-	-	-	-	-	-	48 x 48	504.92	10	505.00
SF-K5	24	488.50	487.00	6	U.D.	488.50	-	-	-	-	-	-	-	-	-	48 x 48	494.35	10	495.00
ED-K5	24	480.00	478.00	2	RPI	480.5/482	39 x 9	R.V.O. (4)	485.25	-	-	-	-	-	-	48 x 48	486.00	10	486.05
ED-K6	30	512.00	510.00	2	RPI	514.5/515	22 x 16	R.V.O. (4)	518.50	-	-	-	-	-	-	48 x 48	519.95	14	520.05

LEGEND	
SFF	= SAND FILTER FOREBAY
SF	= SURFACE SAND FILTER
ED	= MICROPOOL EXTENDED DETENTION BASIN
I	= INFILTRATION BASIN
B	= DRY BASIN
RPI	= REVERSE PIPE INLET - INVERT = IN/OUT
S.P.	= STAND PIPE
U.D.	= UNDERDRAIN
C.V.O.	= CIRCULAR VERTICAL ORIFICE
R.V.O.	= RECTANGULAR VERTICAL ORIFICE
(n)	= NUMBER OF IDENTICAL ORIFICES
(n) x (n)	= DIMENSION 10 x 13 = WIDTH (INCHES) x HEIGHT (INCHES)

NOTES:
 PP = PERMANENT POOL ELEVATION
 1-Y = 1 YEAR STORM = CHANNEL PROTECTION VOLUME ELEVATION
 WQV ELEVATION (NYSDEC & NYCDEP)
 2-Y = 2 YEAR STORM
 10-Y = 10 YEAR STORM = OVER BANK PROTECTION ELEVATION
 25-Y = 25 YEAR STORM ELEVATION
 100-Y = 100 YEAR STORM = EXTREME YEAR EVENT ELEVATION



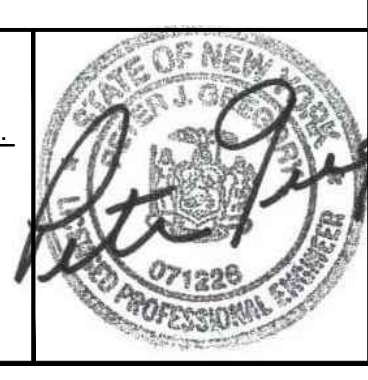
ANY DETAIL NOT SPECIFICALLY SHOWN ON THE SITE PLAN WILL BE UTILIZED WHEN FIELD CONDITIONS WARRANT AS DIRECTED BY THE ENVIRONMENTAL MONITOR
 UNAUTHORIZED ALTERATIONS OR ADDITIONS TO THIS DRAWING IS A VIOLATION OF SECTION 7209, SUB-DIVISION 2, OF THE NEW YORK STATE EDUCATION LAW.

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REV.	DESCRIPTION	BY	DATE
1	NYC DEP COMMENTS	PL	July 24, 2006
2	TOWN REVIEW	PL	Nov 15, 2006
3	TOWN REVIEW	PL	Sept 2, 2008
4	TOWN REVIEW	DPG	April 16, 2010
5	TOWN PLANNER MEMO (7/8/2010) & TOWN ENGINEER MEMO (7/9/2010)	DPG	December 29, 2010
6	TOWN PLANNER MEMO (9/9/2011) & TOWN ENGINEER MEMO (9/3/2011)	DPG	February 24, 2012
7	COMPLETENESS SUBMISSION	DPG	July 31, 2012
8	ACCEPTED DRAWING SET	DPG	September 12, 2012
9	RESOLUTION 139-13	PJG	April 22, 2013

DRAWN BY: PL **CHECKED BY:** DC
SCALE: AS NOTED
DATE: NOVEMBER 11, 2005
JOB NUMBER: **SHEET:**
 DS-8, 37 of 39